




Plan Scale 1:50

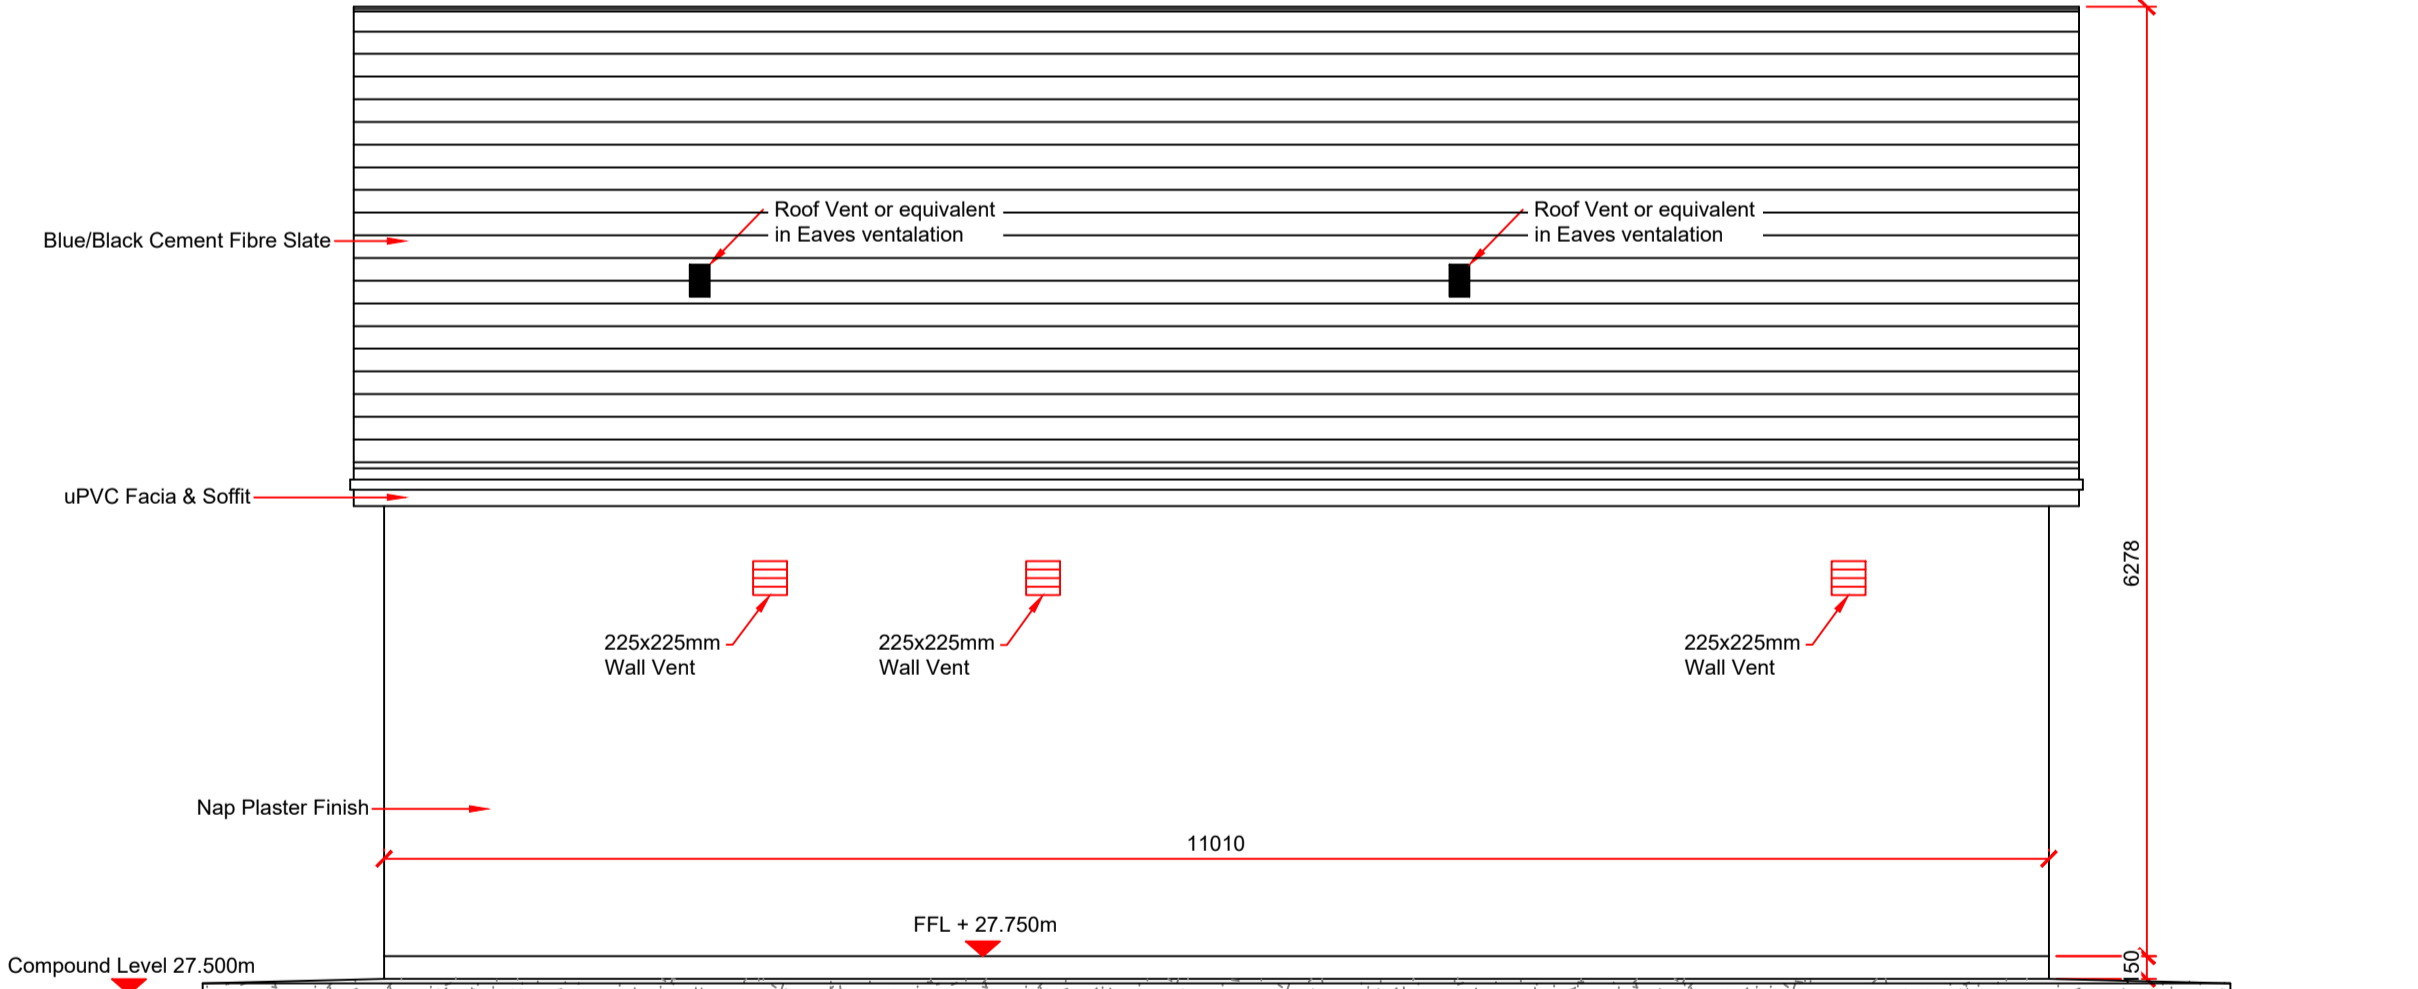


Southeast Elevation Scale 1:50

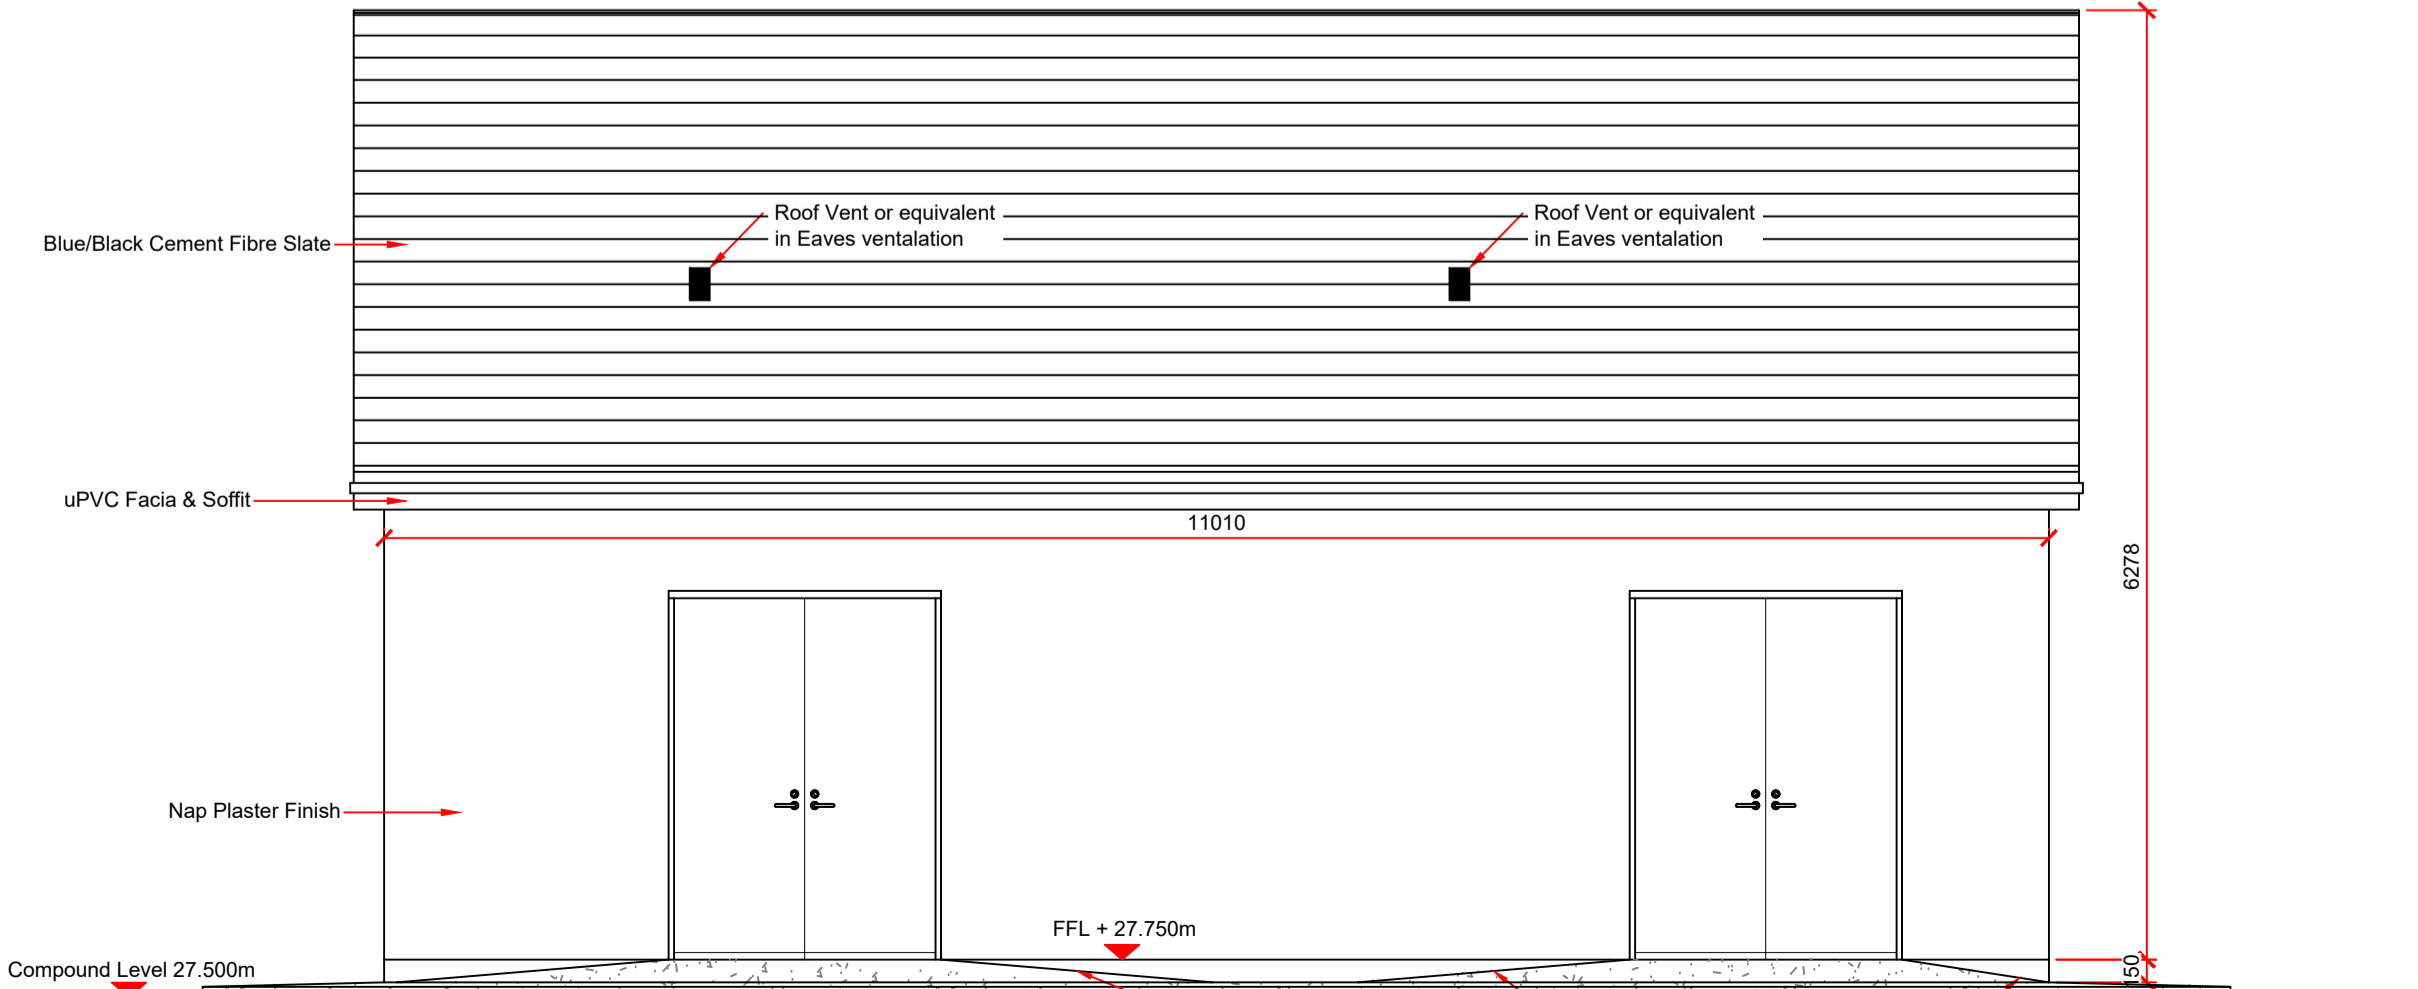


Northeast Elevation Scale 1:50

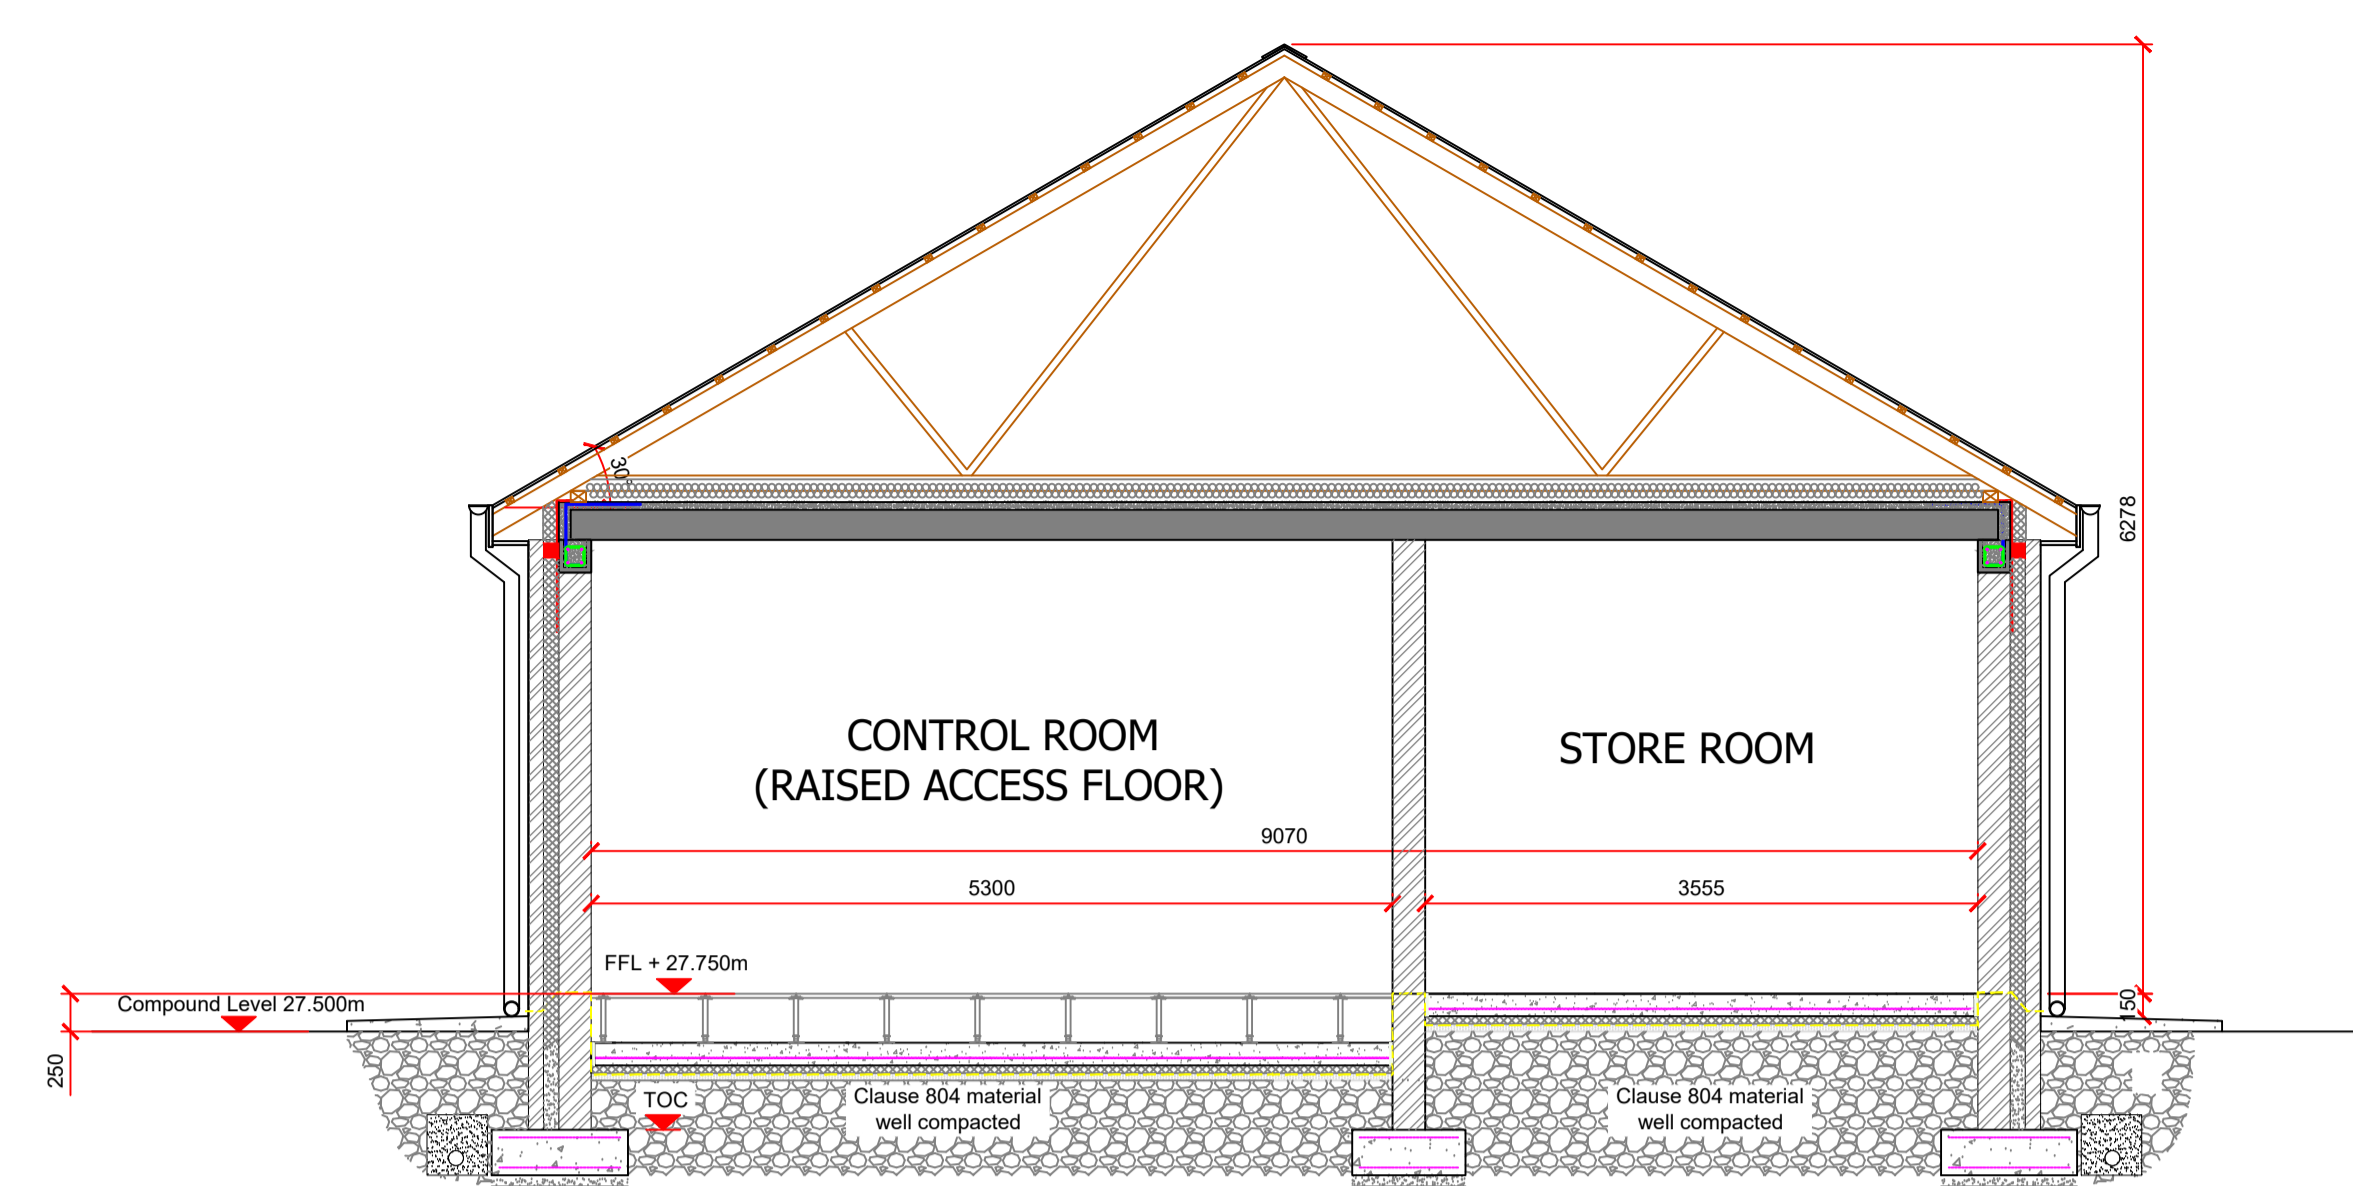

Section A-A Scale: 1:50

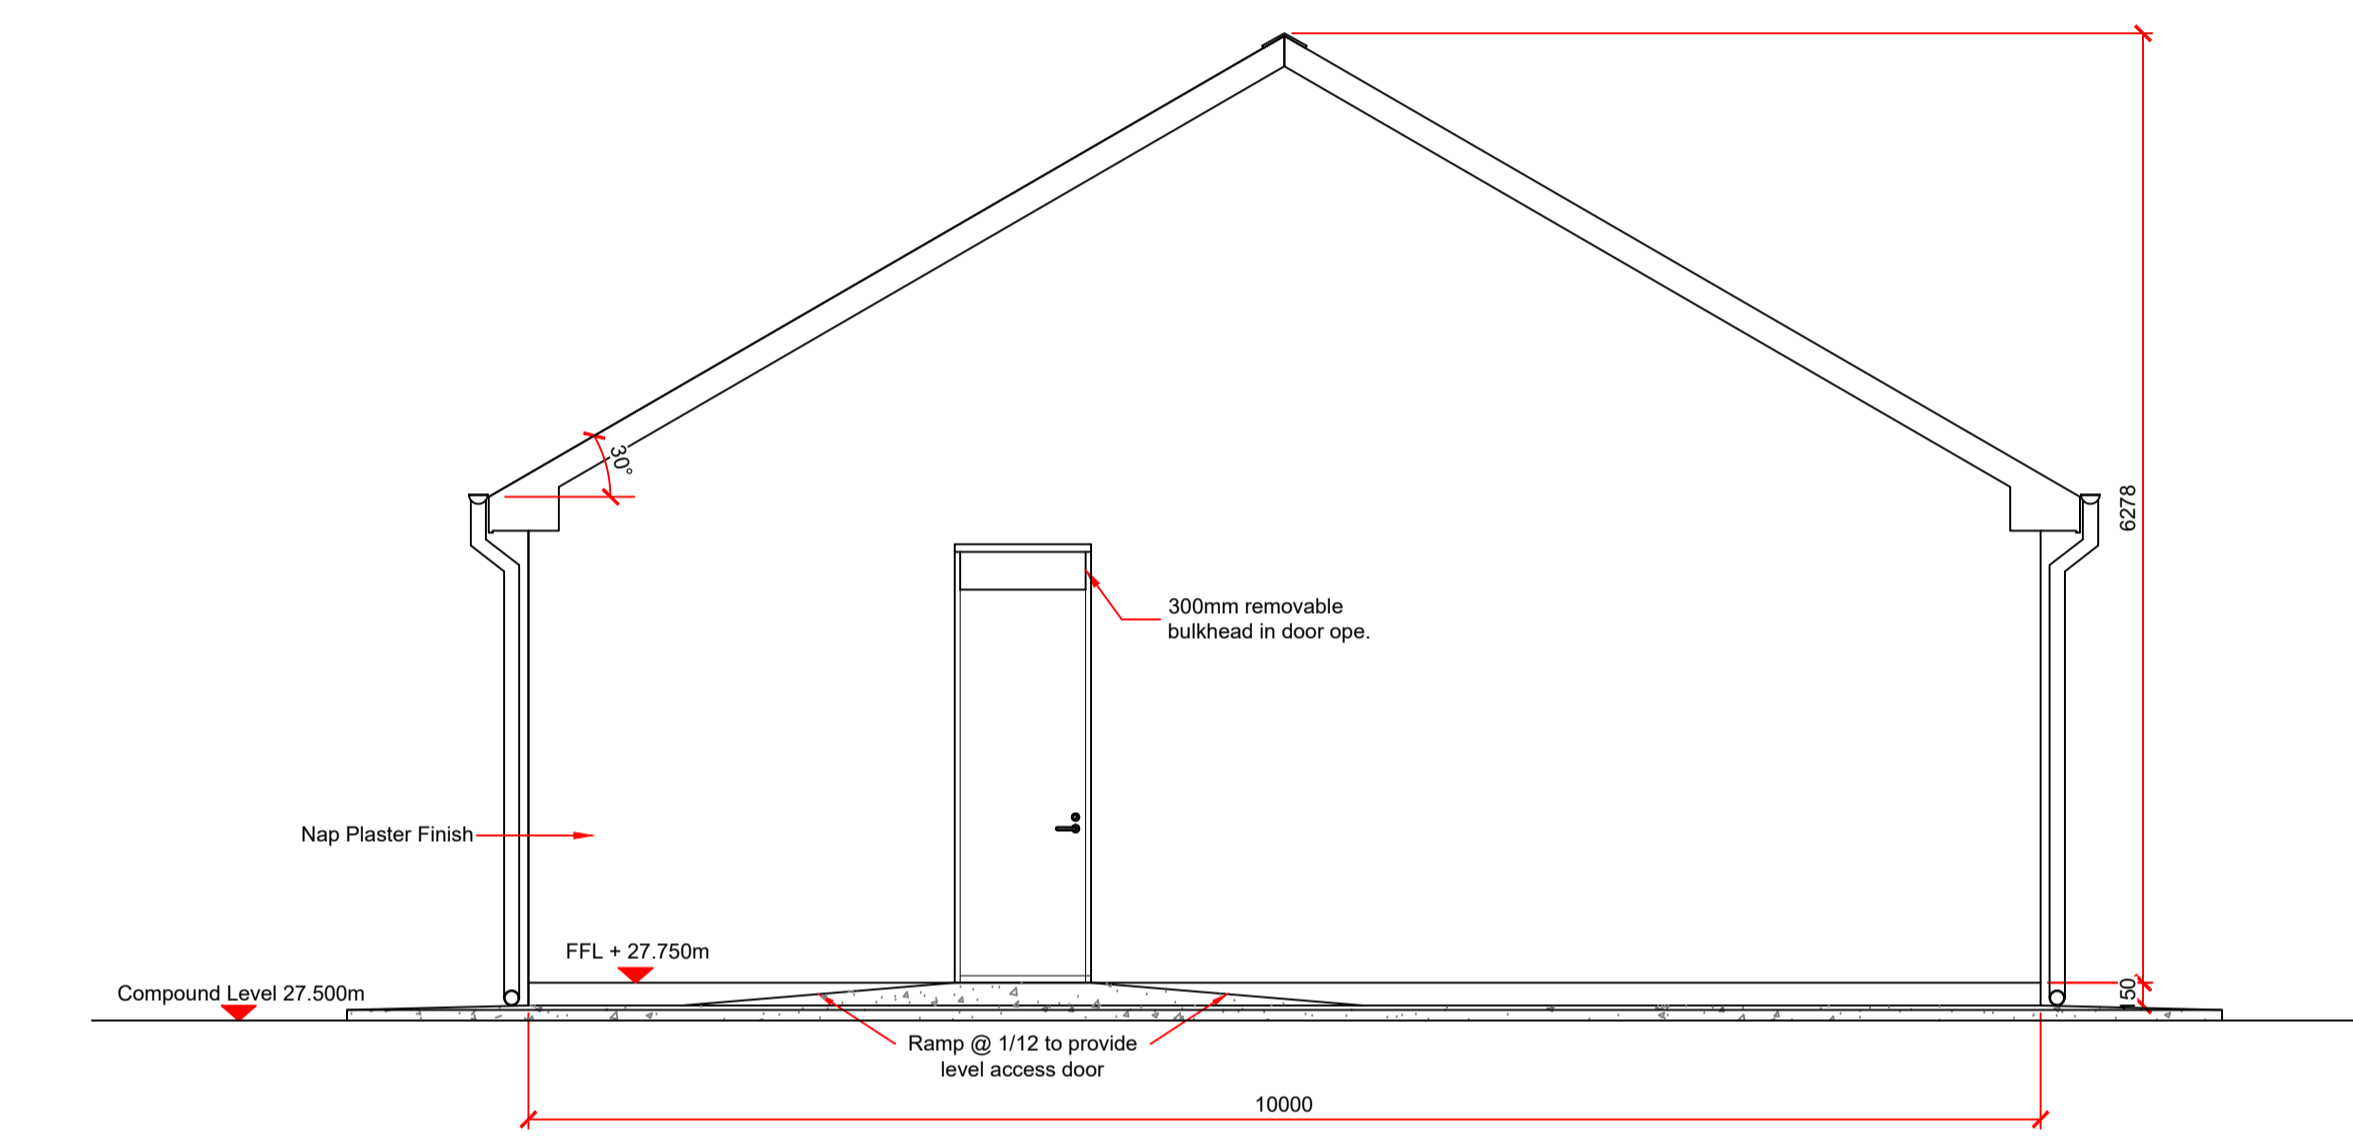

Northeast Elevation Scale 1:50

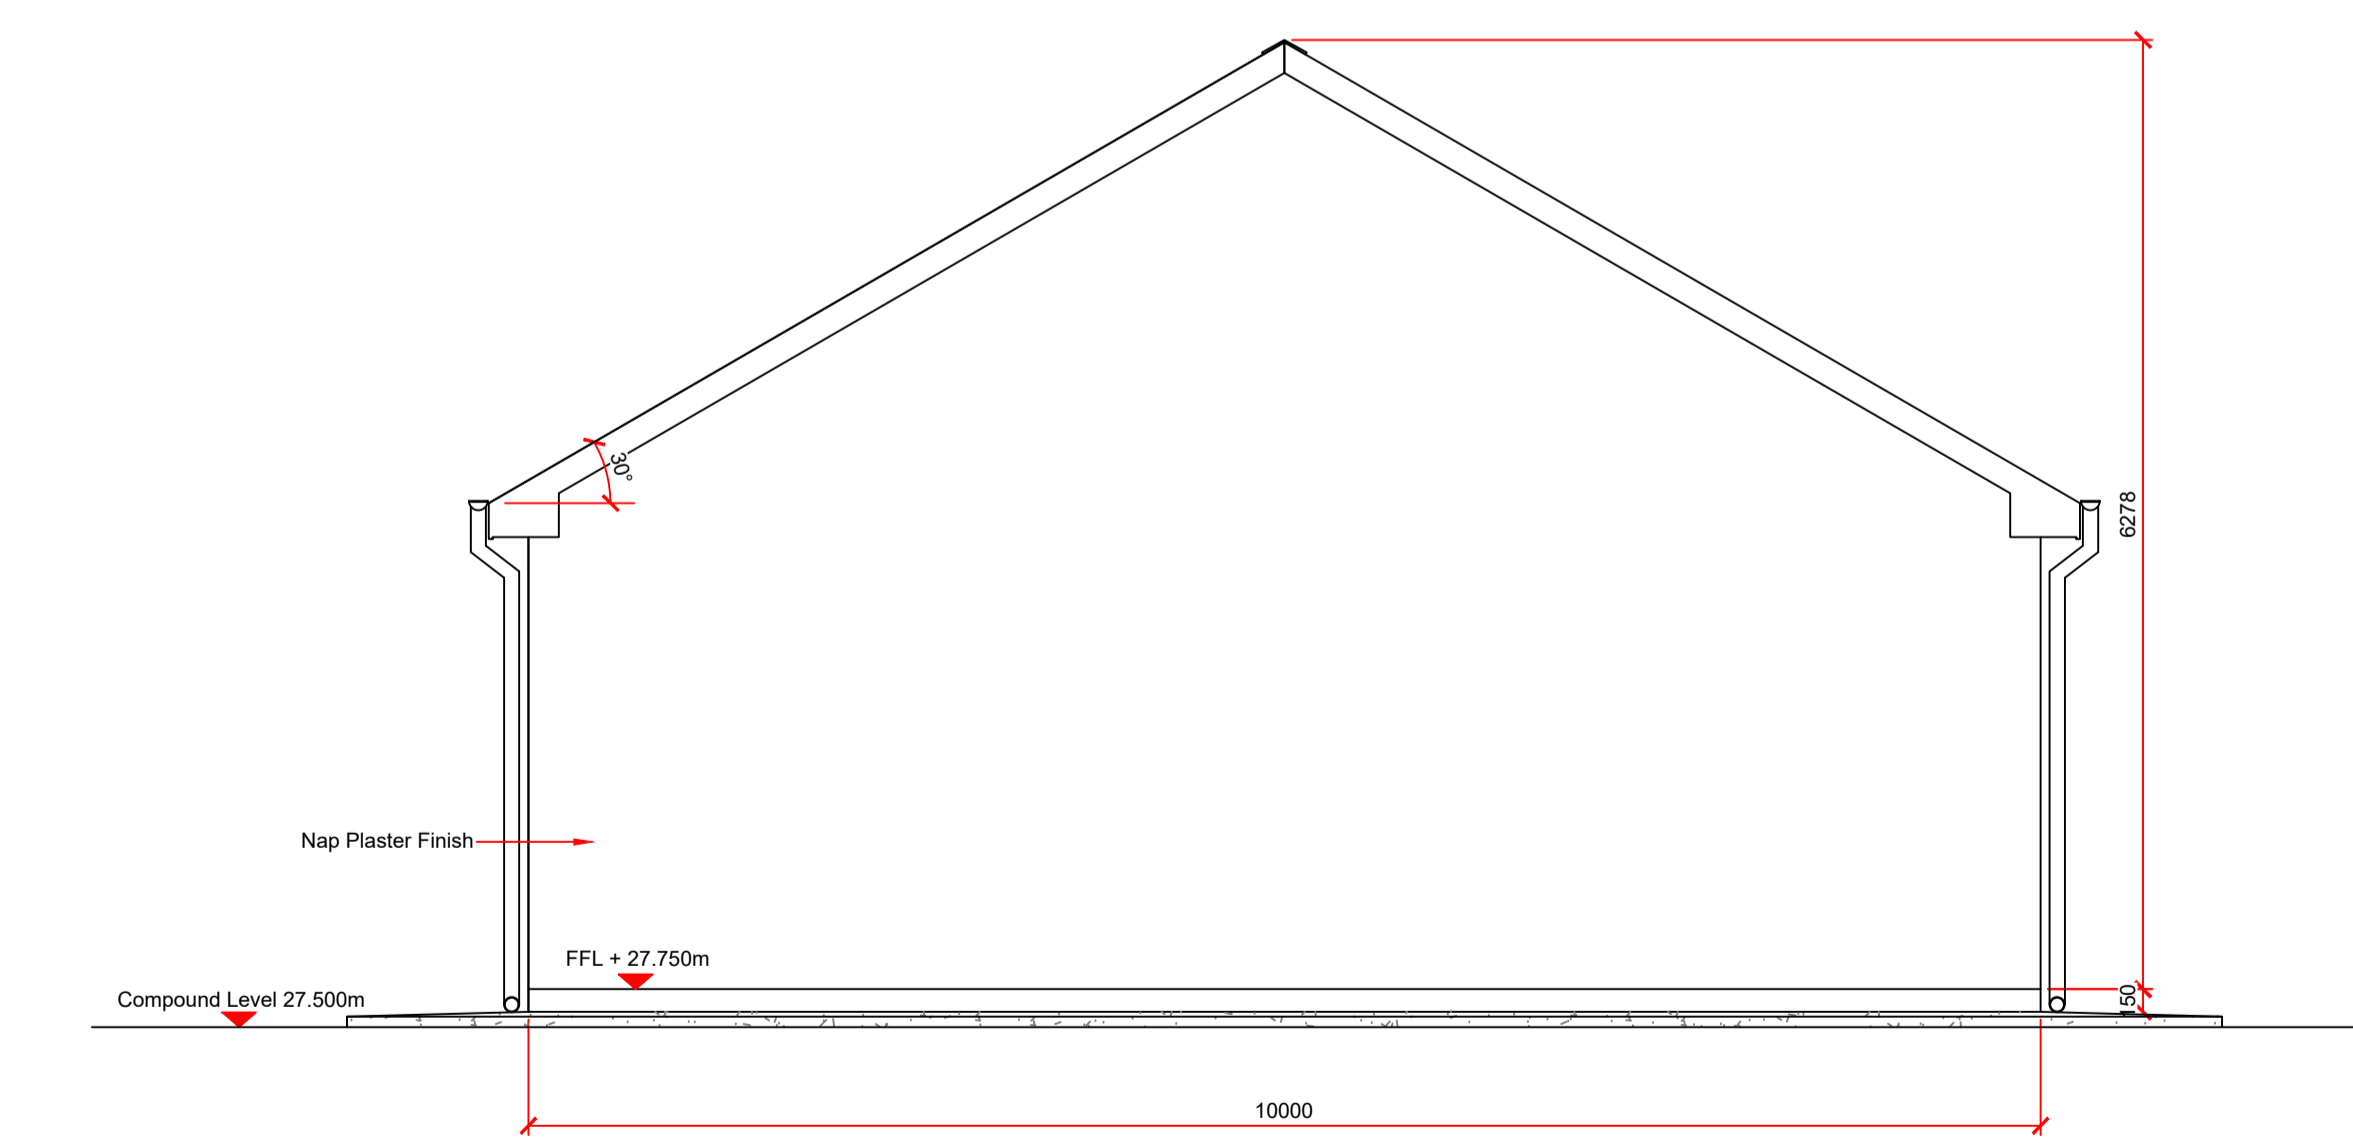

Southwest Elevation Scale 1:50

DO NOT SCALE FROM THIS DRAWING. USE FIGURED DIMENSIONS IN ALL CASES. VERIFY DIMENSIONS ON SITE AND REPORT ANY DISCREPANCIES TO THE DESIGNERS IMMEDIATELY.
 THIS DRAWING IS TO BE READ IN CONJUNCTION WITH THE DESIGNERS SPECIFICATION.
 © THIS DRAWING IS COPYRIGHT AND MAY ONLY BE REPRODUCED WITH THE DESIGNERS PERMISSION.

NOTES:

1. ALL DRAWINGS ARE TO BE READ IN CONJUNCTION WITH ALL RELEVANT SPECIFICATIONS, BILLS OF QUANTITIES, ARCHITECTURAL, SERVICES AND ENGINEERING DRAWINGS.
2. ALL LEVELS ARE IN METRES RELATED TO ORDNANCE DATUM MALIN HEAD.
3. ANY DISCREPANCIES BETWEEN THESE DOCUMENTS SHALL BE BROUGHT TO THE ATTENTION OF THE ENGINEER.
4. DRAWINGS ARE NOT TO BE SCALED.
5. ALL DIMENSIONS ARE IN MILLIMETRES, UNLESS NOTED OTHERWISE.
6. THE FINALISED LAYOUT MAY BE SUBJECT TO MICRO-SITING DUE TO UNFORESEEN GROUND CONDITIONS. THE EXTENT OF FLEXIBILITY WILL BE SITE SPECIFIC AND SHOULD GENERALLY NOT EXCEED BEYOND 20 METRES.

REFERENCE DRAWINGS:

DRAWING No.	Proposed Site Layout - Master Sheet
19876-MWP-00-00-DR-C-5005	Proposed Substation Compound Layout

LEGEND

	Concrete Footpath (Impermeable)
	100mm Ø uPVC Foul Water Pipe
	100mm Ø uPVC Storm Water Pipe
	Foul Water AJ
	Foul Water Manhole
	Storm Water AJ
	Storm Water Manhole

P01	14/01/2021	Issued For Planning	JK	JK	
REV	DATE	DESCRIPTION	BY	APP	
PROJECT: Shronowen Wind Farm					
TITLE: IPP Substation Building - Plan, Elevations & Section					
CLIENT: Shronowen Wind Farm Limited					
Malachy Walsh and Partners Engineering and Environmental Consultants Cork Tralee London Limerick					
Reen Point, Blennerville, Tralee, Co. Kerry, V92 X2TK Tel: +353 (0) 66 7123404 Fax: +353 (0) 66 7125586 E-mail: tralee@mwp.ie Web: www.mwp.ie					
DRAWN:	JK	CHECKED:	PC	APPROVED:	PC
DATE:	September 2020	SCALE @ A1:	1:50		
PROJECT NUMBER:	19876	DRAWING STATUS:	S2		
DRAWING NUMBER:	19876-MWP-00-00-DR-C-5413	REV:	P01		